

# Town of Long Island



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BUILDING PERMIT APPLICATION# 647

LOT# 226 ZONE \_\_\_\_\_ LOT SIZE 1.3 STREET LOCATION 65 Island Ave.

OWNER/APPLICANT Cynthia MacDonald Natalie and David Truesdell

OWNER/APPLICANT ADDRESS 69 Cumberland St Yarmouth ME 04096

TELEPHONE HOME 765-490-6181 WORK \_\_\_\_\_ CELL \_\_\_\_\_

CONTRACTOR Phil Fabiano

ADDRESS 11 Gerry Ave.

TELEPHONE WORK \_\_\_\_\_ CELL 207-329-5110 JOB SITE \_\_\_\_\_

EMAIL iblongtoo@yahoo.com

## APPLICATION TYPE

☒ NEW PRINCIPAL STRUCTURE \_\_\_\_\_ ADDITION \_\_\_\_\_ RELOCATION  
\_\_\_\_ NEW ACCESSORY STRUCTURE \_\_\_\_\_ ALTERATION \_\_\_\_\_ REPLACEMENT  
\_\_\_\_ REPAIR

## PROJECT DESCRIPTION (BRIEF EXPLANATION OF WORK TO BE DONE):

Build a 2 story/ 3 bedroom/ 2 bath home

DIMENSIONS OF PROPOSED STRUCTURE 26'x36'

## PROPOSED FOUNDATION TYPE:

\_\_\_\_ FULL 10' \_\_\_\_ FULL 8' \_\_\_\_ 4' FROST WALL \_\_\_\_ PIER \_\_\_\_ ☒ SLAB

## SETBACKS OF PROPOSED STRUCTURES (MUST BE SHOWN ON "REQUIRED" SITE PLAN)

FRONT 64 FT SIDES 2238 FT/ \_\_\_\_\_ FT REAR 212 FT



**BUILDING HEIGHT**

THE VERTICAL DISTANCE FROM THE AVERAGE ORIGINAL GRADE TO THE TOP OF THE HIGHEST ROOF BEAMS OF A FLAT ROOF, OR TO THE MEAN LEVEL OF THE HIGHEST GABLE OR SLOPE OF GABLE OR HIP ROOF. (MAX 35' ALLOWED)

EXISTING STRUCTURES N/A FT

PROPOSED STRUCTURES \_\_\_\_\_ FT

**FOR STRUCTURES TO BE OCCUPIED OR FOR AN INCREASE IN THE # OF BEDROOMS TO BE SERVICED BY PRIVATE SEPTIC SYSTEM:**

# OF EXISTING BEDROOMS 3 # OF ADDITIONAL BEDROOMS 2**CEO PERMIT CHECKLIST:**

SEASONAL CONVERSION \_\_\_\_\_ YES \_\_\_\_\_ NO  
SEPTIC REVIEW NEEDED \_\_\_\_\_ YES \_\_\_\_\_ NO  
SEPTIC DESIGN NEEDED \_\_\_\_\_ YES \_\_\_\_\_ NO  
EXISTING LOT COVERAGE \_\_\_\_\_ OVER ON COVERAGE \_\_\_\_\_ YES \_\_\_\_\_ NO

NO BUILDING HEREAFTER ERECTED SHALL BE OCCUPIED OR USED, IN WHOLE OR IN PART, UNTIL A CERTIFICATE OF OCCUPANCY SHALL HAVE BEEN ISSUED BY THE CODE ENFORCEMENT OFFICER.

MINIMUM OF THREE INSPECTION REQUIRED FOR ALL CONSTRUCTION WORK.

1. FOUNDATIONS (FOOTINGS, WALLS, DRAINAGE, WATER PLUG)
2. FRAMING (PRIOR TO COVERING STRUCTURAL MEMBERS)
3. FINAL INSPECTION BEFORE OCCUPANCY

SEPARATE PERMITS ARE REQUIRED FOR ELECTRICAL, PLUMBING AND SHORELAND CONSTRUCTION MAY REQUIRE MAINE DEP PERMIT

THIS PERMIT APPLICATION DOES NOT PRECLUDE THE APPLICANT(S) FROM MEETING APPLICABLE STATE AND FEDERAL RULES.

**THIS PERMIT WILL BE COME NULL AND VOID IF CONSTRUCTION IS NOT STARTED WITHIN SIX MONTHS OF PERMIT ISSUE DATE.**

I HEREBY CERTIFY THAT I AM THE OWNER OF RECORD OF THE NAMED PROPERTY, OR THAT I HAVE BEEN AUTHORIZED BY THE OWNER TO MAKE THIS APPLICATION AS THEIR AGENT. I AGREE TO CONFORM TO ALL APPLICABLE LAWS OF THIS JURISDICTION. IN ADDITION, IF THIS PERMIT IS ISSUED, I CERTIFY THAT THE CODE OFFICIAL OR HIS REPRESENTATIVE SHALL HAVE THE AUTHORITY TO ENTER ALL AREAS COVERED BY SUCH PERMIT AT ANY REASONABLE HOUR FOR THE PURPOSES OF INSPECTING SAID WORK.

PRINTED NAME Cynthia MacDonald David and Natalie Truesdell OWNER/AUTHORIZED AGENTSIGNED Cynthia Macdonald David and Natalie Truesdell DATE August 22, 2022  
OWNER / AUTHORIZED AGENTAPPROVED BY CODE ENFORCEMENT OFFICER YES \_\_\_\_\_ NOSIGNED [Signature] DATE 8/26/22

ESTIMATED COST INCLUDING MATERIALS &amp; LABOR \$ \_\_\_\_\_

PERMIT FEE: \$ 561.60  
(SEE PAGE 4 FOR PERMIT FEE SCHEDULE)PAID: CASH \_\_\_\_\_ CHECK# 2224  
8/31/22



## General Notes:

1. All materials, workmanship, design, and construction shall conform to the drawings, specifications, and to the most recent edition of state, local and federal regulations.
2. Install all materials, products and fixtures per the manufacturer's installation requirements.
3. For additional information on building systems and components refer to the Specifications.
4. Plan dimensions are to the face of studs and face of foundation, unless otherwise noted. Do not scale any drawings for dimensions undefined.
5. Drawings indicate general and typical details of construction. Where conditions are not specifically indicated but are of similar character to details shown, the contractor shall use similar details of construction.
6. At each phase of work, the Contractor shall verify all relevant grades, existing dimensions, member sizes, and conditions prior to commencing any work.

## Grant of License

In consideration of payment for these construction documents, Rose Chapin Architects (RCA) grants Licensee a nonexclusive right to use and to construct ONE structure from these documents. Additional licenses may be obtained by contacting the RCA office. RCA reserves all rights not expressly granted to Licensee.

## Stock Plan General Notes & Disclaimers

- 1) These drawings have been prepared to meet generally accepted professional standards and practices, but have been developed without knowledge of or reference to the Licensee's specific site or geographical location. Local site conditions, such as frost depth, soil bearing capacity, seismic and wind zones, exposure, etc. may vary. Local code requirements for such life-safety requirements as stair width, stair rise and run, egress windows and smoke detectors, etc. may vary. The strength of materials (such as lumber) available locally may vary. Therefore, supplemental to these documents, it is the Licensee's responsibility to consult with his/her local builder and a professional designer or structural engineer to determine that these documents meet all current federal, state/provincial and local codes, ordinances/bylaws and regulations, etc. and are appropriate to specific site conditions. Compliance with such requirements shall take precedence over these documents. The Licensee has the responsibility for contracting a professional engineer to provide stamped & signed engineering drawings, details and calculations.
- 2) Any use of this information without adaptation to changes in codes, standards, site conditions and other factors is at the Licensee's sole risk. Rose Chapin Architects (RCA) assumes no responsibility for changes made to these plans by others and makes no warranties, either expressed or implied, in the use of these plans. The Licensee agrees to defend and indemnify RCA for all claims, costs, losses or damages resulting from the use of these documents.
- 3) Before starting construction, it is the builder's responsibility to check all dimensions and details, and verify conformance with governing code requirements for the geographic area in which the house is to be built. All structural, mechanical and electrical requirements shall also be reviewed before construction begins. Codes govern over drawings and dimensions govern over scale. Notify the architect of dimensional discrepancies.
- 4) RCA has not been engaged for construction supervision of any kind and assumes no responsibility to ensure that construction conforms to these plans, nor has any responsibility for construction means, methods, techniques, sequences, procedures or safety precautions in connection with this work.
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- 6) These drawings and specifications are copyrighted. Unauthorized copying of these documents is expressly forbidden. The Licensee is granted the right to make copies as needed for the construction of one (1) building per plan purchase. Any other copying is unauthorized. The Licensee may be held legally responsible for any copyright infringement that is caused or encouraged by the failure to adhere to the terms of this agreement.

## Project Information

Licensee:  
Address:  
Email:  
Building Site Address:  
Site Phone:  
Parcel Number:  
Legal Description:


Building Areas:	First Floor	606 SF
	Second Floor	480 SF
	Covered Porch	210 SF
<b>Total Heated Living Area</b>	<b>1086 SF</b>	


## Symbol Legend

	Window Number		Wood Frame Wall
	Door Number		Wood Frame Insulated Wall
	Shear Wall Type		Hold Down Type
	Building Section		Center Line
	Sheet Number		Blocking
	Detail Number		Finish Lumber
	Detail Number in Project Manual		Plywood

## Schedule of Drawings

Sheet #	Contents
11	Cover Sheet, Project Information, Key, Abbreviations
4.1	First Floor Plan
4.2	Second Floor Plan
5.1	Foundation and First Floor Framing Plan
5.2	Second Floor Framing Plan
5.3	Roof Framing Plan
6.1	Section A-A, Building Systems
7.1	Front Elevation
7.2	Side Elevation
7.3	Back Elevation
7.4	Side Elevation
8.1	First Floor Electrical Plan
8.2	Second Floor Electrical Plan
9.01	Interior Elevations
11.1	Window Schedule, Door Schedule
11.2	Shear and Hold-down Schedule
	Construction Specifications Appendix

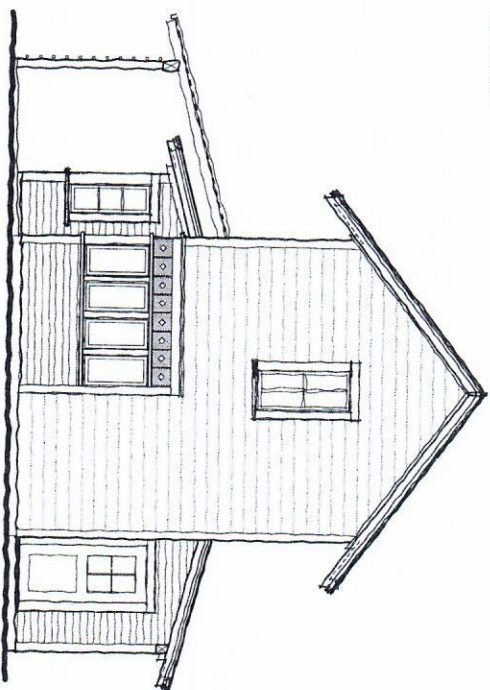

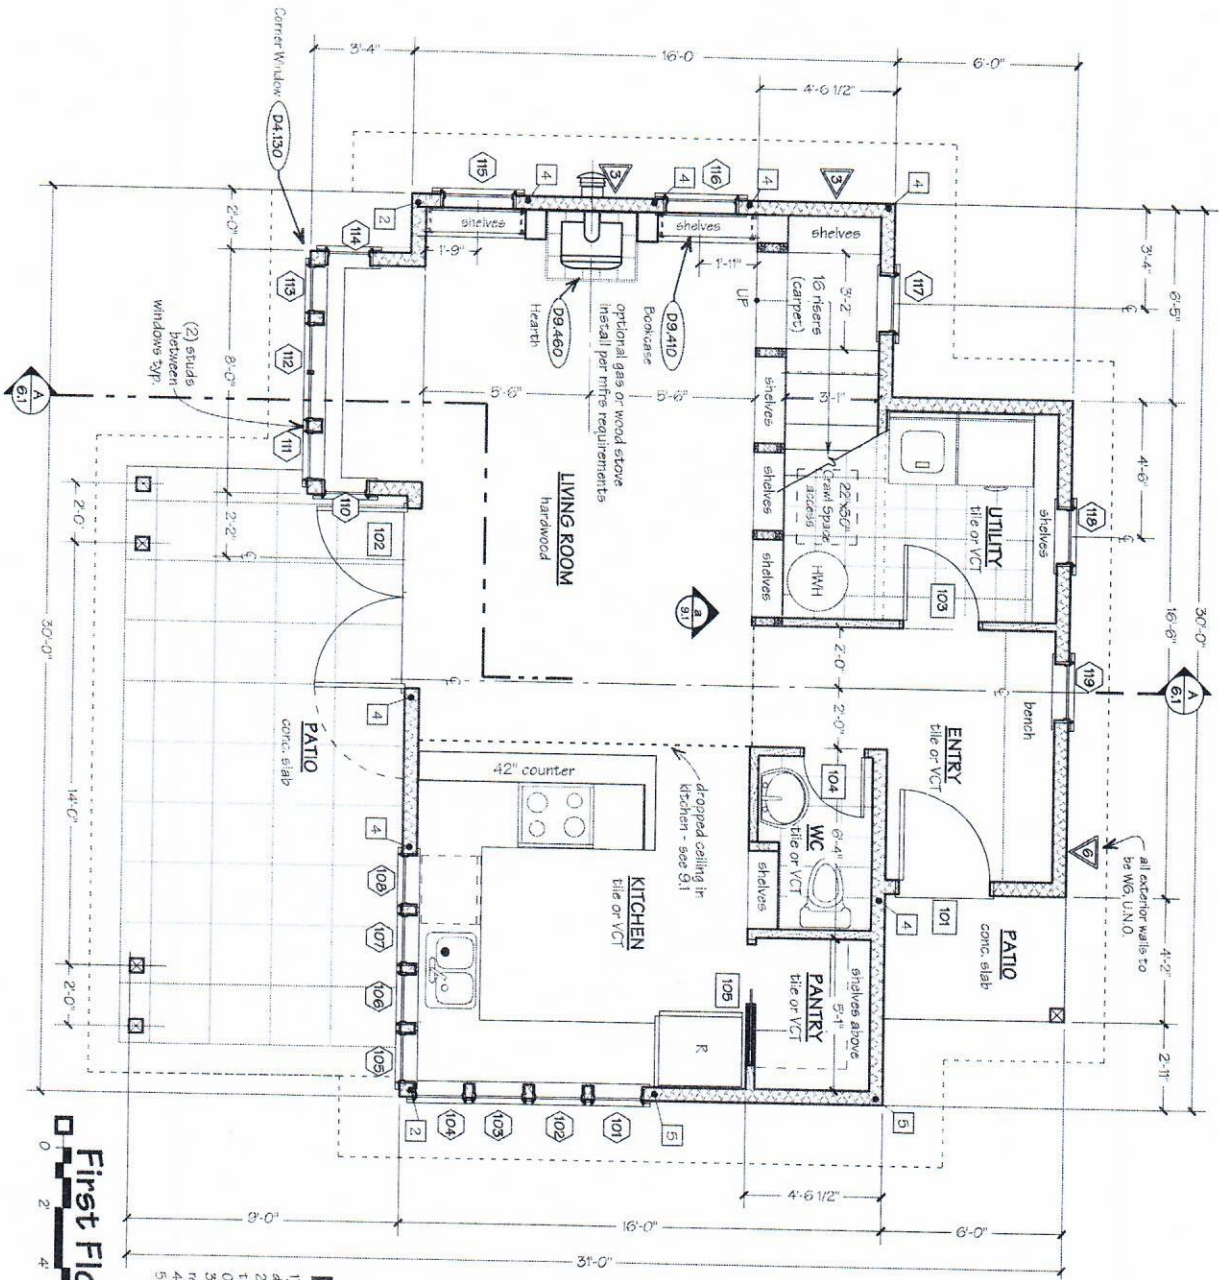








Crawlspace Ventilation  
Requirements  
(1) 0.47 ventilation per ISO 67  
Crawlspace Area: 600 sq ft  
(requires 4 sq ft ventilation)  
(2) Foundation vents  
157x133x75 efficient = 4 sq ft

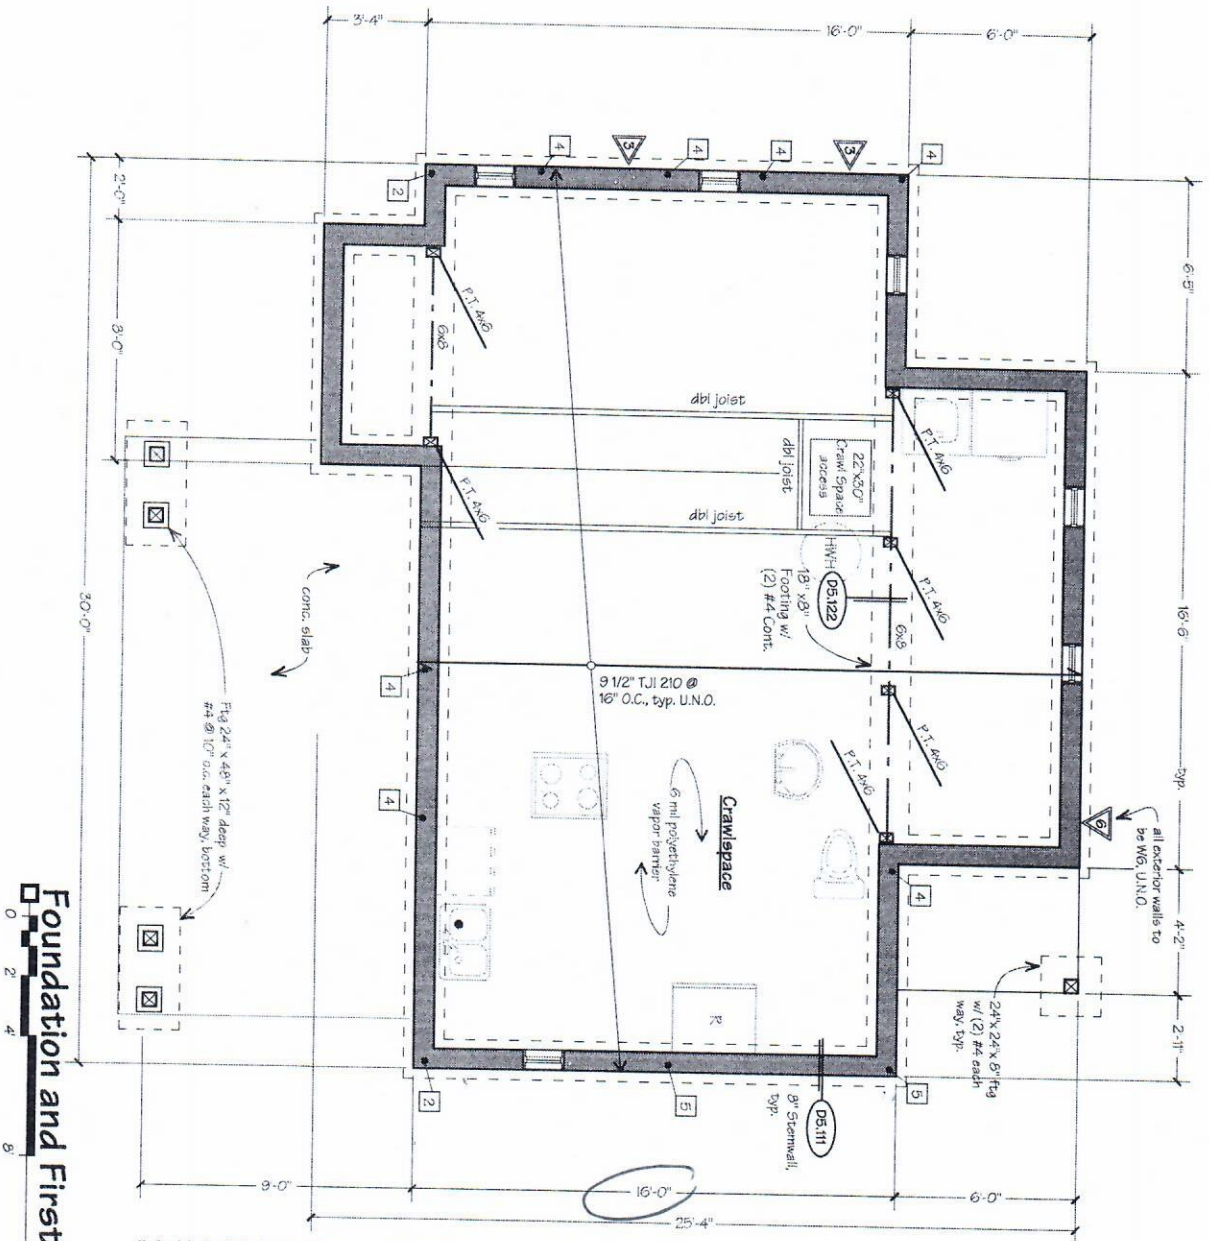


Foundation and First Floor Framing Plan

- Framing Notes**
- 1) It is the owner's responsibility to consult with a structural engineer to determine that these documents meet all current Federal, state/provincial and local codes, ordinances, bylaws and regulations, etc., and are appropriate to specific site conditions.
  - 2) At each phase of the Work, verify all relevant dimensions before proceeding with the work.
  - 3) Exterior studs - 2x6 HF #2 @ 16" o.c.
  - 4) All walls to be 5Wt U.N.O.
  - 5) All door and window headers are (2) 2x6 HF #2, except as noted.
  - 6) The bottom of all exterior footings shall be 4" above local frost level.
  - 7) Note that framing plan is responsible for location of hold-downs, U.N.O.
  - 8) Typical floor framing consists 3/4" T&G plywood floor girders perpendicular to supports over TJI framing per plan. Glue & nail sheathing with Bd @ 6" o.c. edges and 12" o.c. field.
  - 9) Block for (1) joist space @ 16" o.c.
  - 10) Use double joists where indicated.
  - 11) Provide (2) bearing studs each of all headers over 4 feet in length, beams, and girder trusses, U.N.O.
  - 12) For additional information on building systems refer to Sheet G-1, Details and Specifications in the Project Manual.







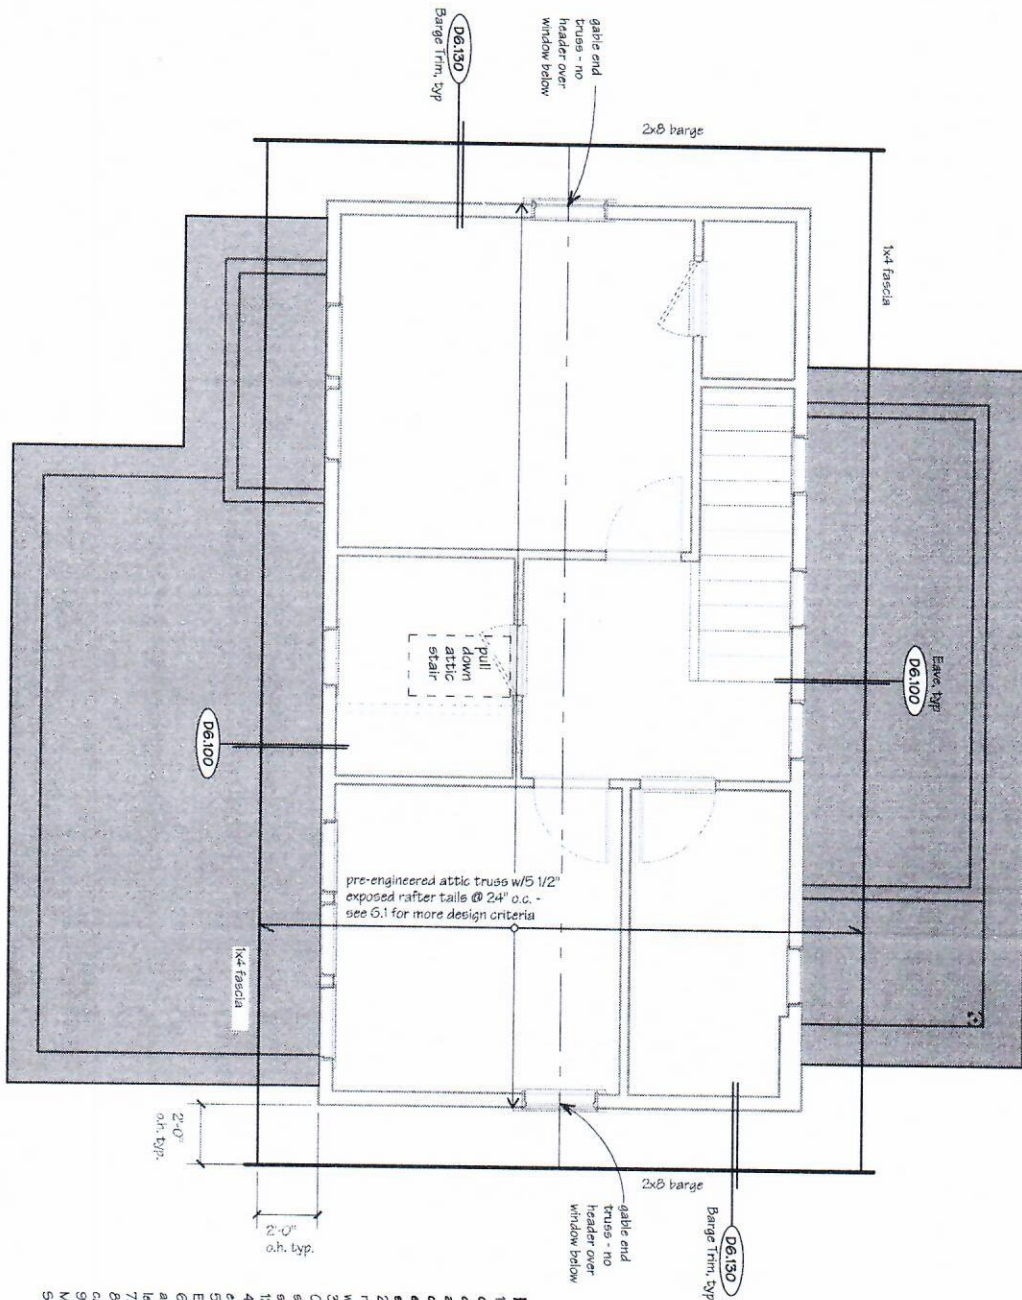

**Roof Framing Plan**

#### Framing Notes

1. It is the owner's responsibility to consult with a structural engineer to determine that these documents meet all current federal, state and local codes, ordinances and regulations, etc., and are appropriate to specific site conditions.
2. At each phase of the Work, verify all relevant dimensions before proceeding with the work.
3. Typical roof framing consists of 1/2" CDX plywood, face grain perpendicular to supports over roof framing per Plan. Nail sheathing with 8d at 6" o.c. edges, 12" o.c. field.
4. Provide 1H Hurricane tie to each sawe end of all roofing members.
5. Headers shall be (2) 2x6 un.a. See Elevation sheets for header heights.
6. Provide (2) bearing studs each end of all headers and beams over 6'-0" in length un.a.
7. All exterior walls shall be SMI un.a.
8. Provide AC, ACE, LFC, or LCE column cap at all beam to column connections.
9. Refer to Details & Notes in Project Manual for additional requirements and Sizer & Holdown schedules.



## Building Systems

### Main Roof Systems

Roofing: asphalt composition roofing  
 15/8" felt  
 5/8" CDX plywood sheathing  
 At eaves: 5/8" LP SmartSide Panel w/ 4" grooves perpendicular to rafters  
 Pre-manufactured attic truss w/ 14" raised heel, 2x6 top chord, 2x8 or 2x10 bottom chord, attach to wall w/ Simpson Hi 12 (R43) fiberglass insulation  
 5/8" gypsum wallboard  
 Vapor barrier PVA sealer (heavy coat for 10 perm rating)  
 Paint: per schedule

### Porch Roof System

Corrugated polycarbonate panels, clear, with  
 Marquing wood nailing strips at 32" o.c.  
 1x4 cedar ship sheathing @ 8" o.c. natural finish  
 4x6 rafters @ 24" o.c.

### Second Floor System

Flooring per plan  
 3/4" CDX 1x4 plywood - glue and screw  
 Joists per plan  
 3 1/2" acoustical insulation  
 5/8" gypsum wallboard or 1x6 pine T & G w/light whitewash stain

### First Floor System


Flooring per plan  
 3/4" CDX 1x4 plywood - glue & nail  
 Joists per plan  
 R-20 fiberglass batt insulation

### Wall System



Siding: 5/16" fiber-cement, exposure and pattern per elevations  
 Weather-resistive barrier  
 Sheathing per stud schedule  
 Exterior wall framing: 2x6 HF #2 @ 24" o.c. U.O.N.  
 Insulation: 5 1/2" floor in blanket spray insulation (R22)  
 Interior surface: 1/2" Gypsum wallboard  
 Vapor barrier: PVA sealer (10 perm rating)  
 Interior paint: per schedule

### Foundation System

2x6 pressure treated sill over sill sealer  
 8" concrete stemwall  
 8" x 16" concrete footing  
 Reinforcing and holdowns per structural

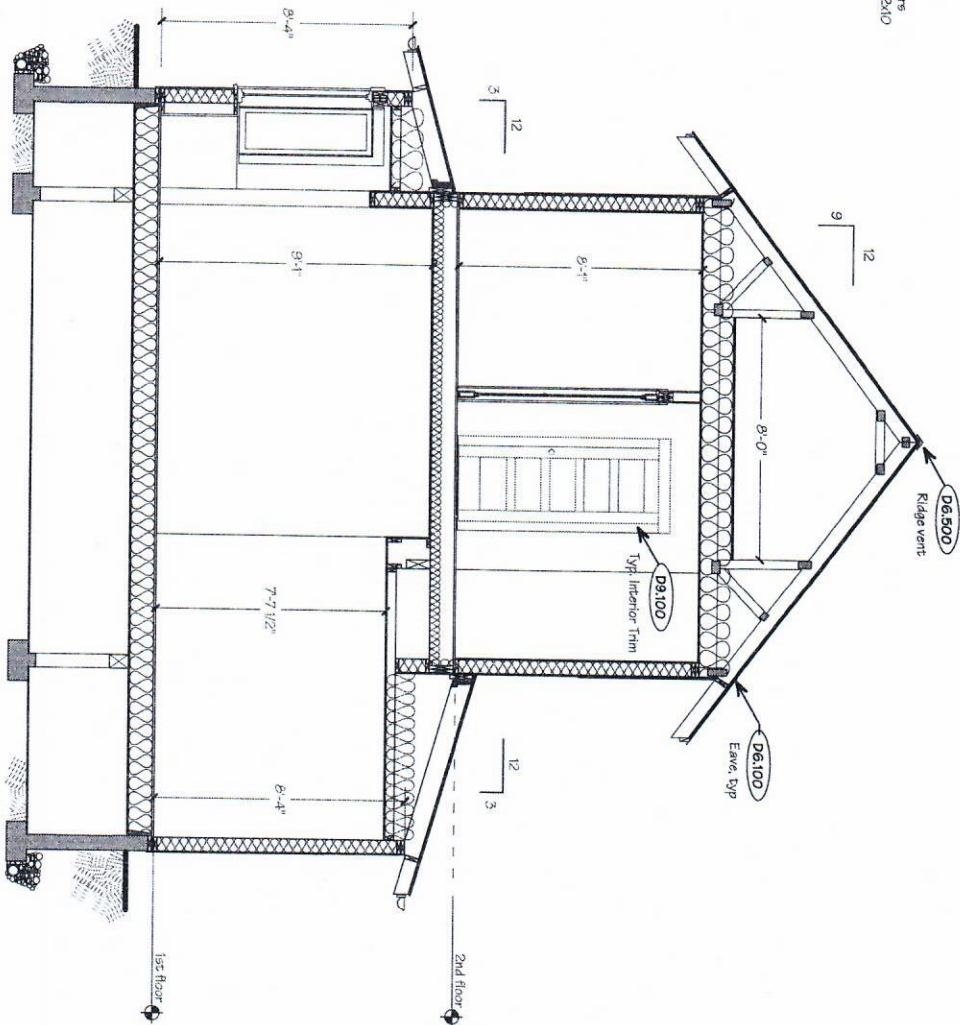


Section A-A

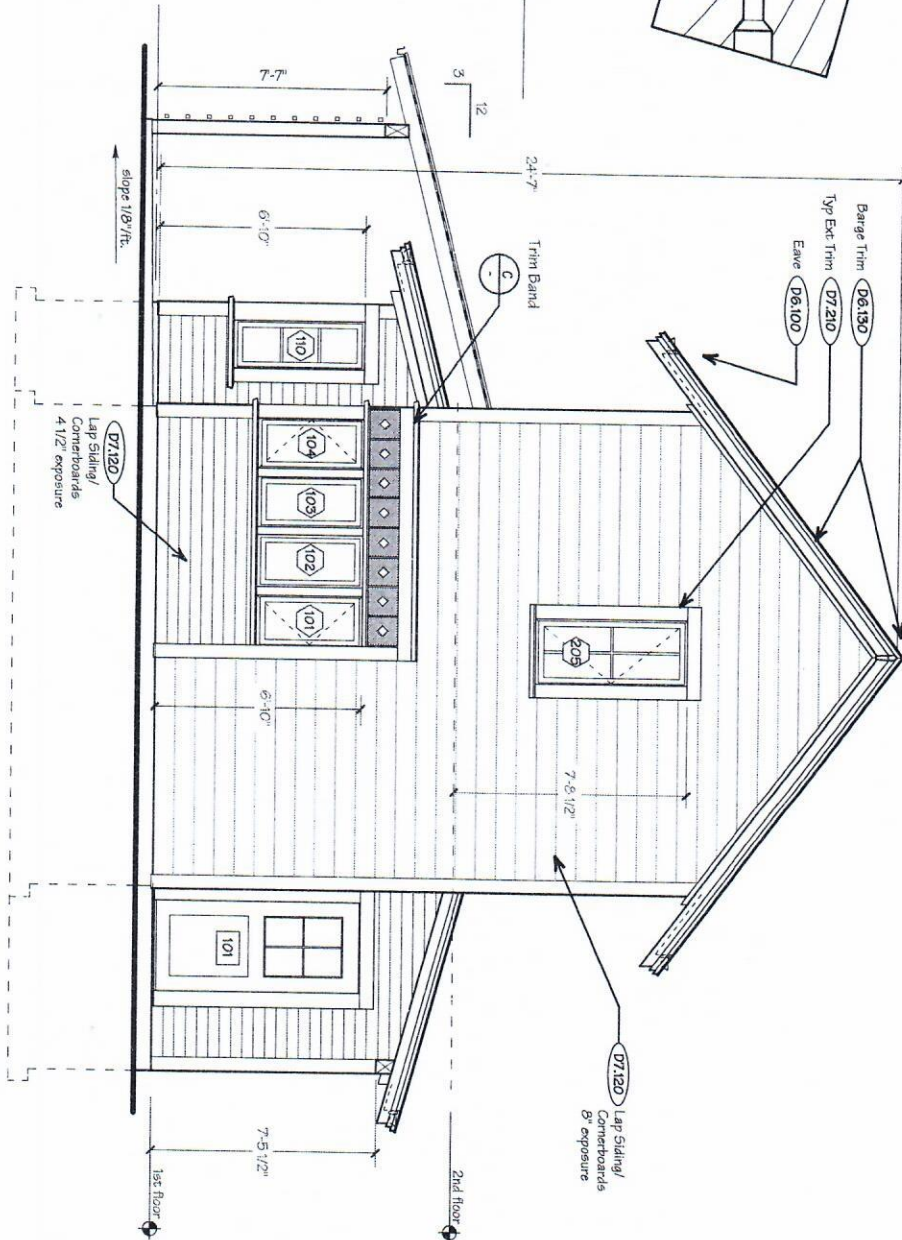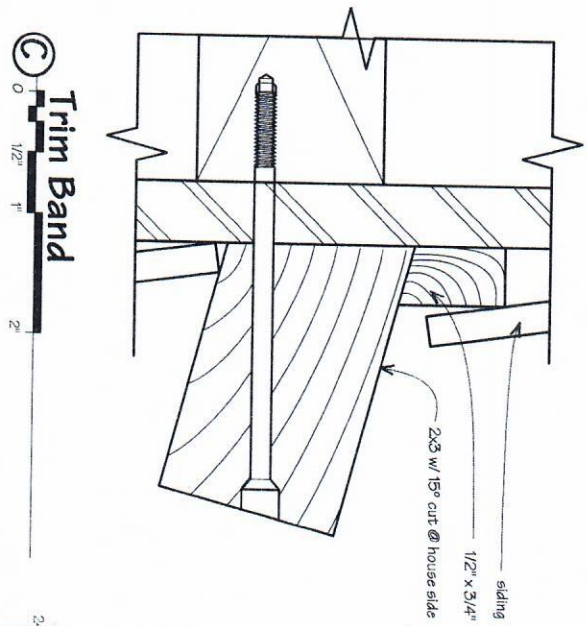

Front Elevation




Left Elevation

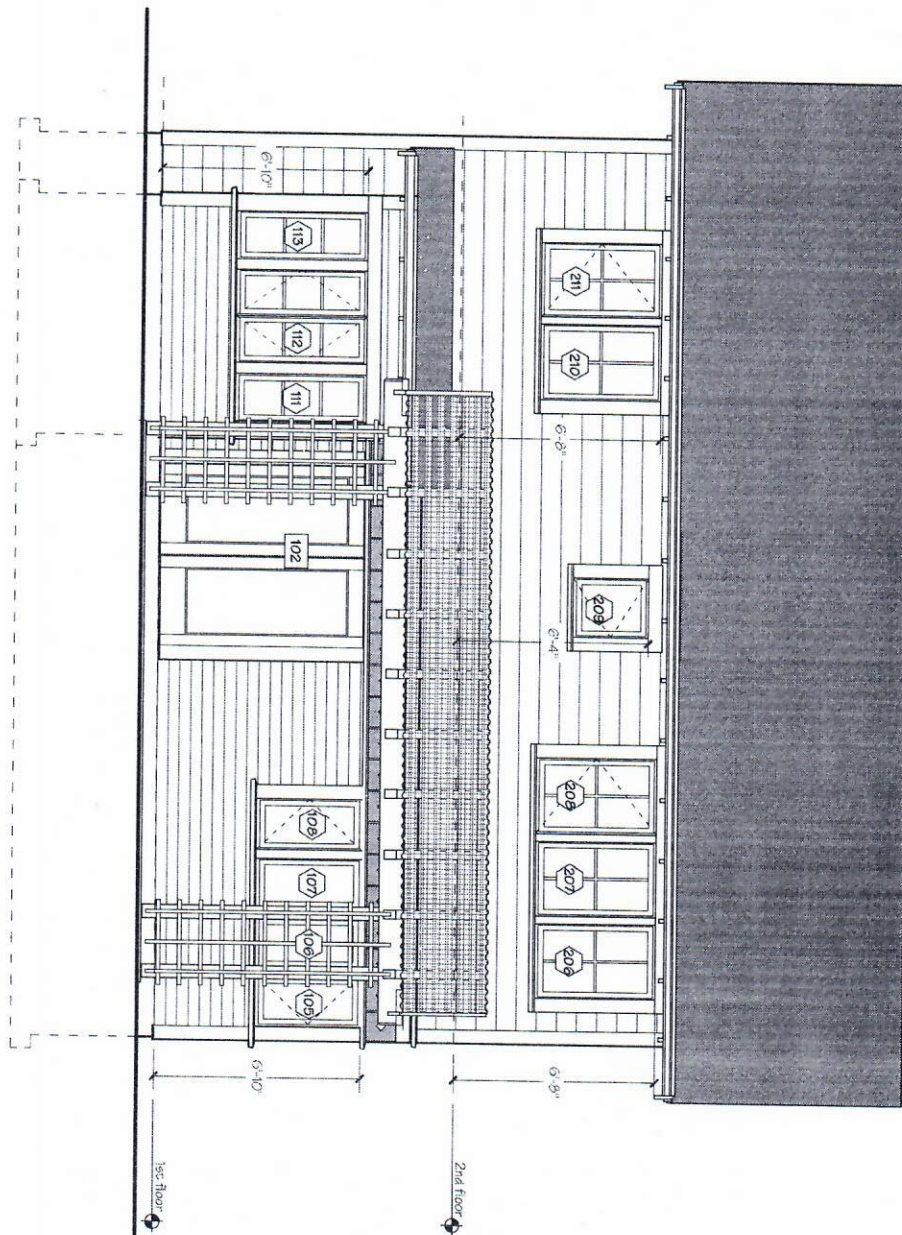


7.2  
ELEVATION

Brightside

GoodFit  
Cottages and Small Houses  
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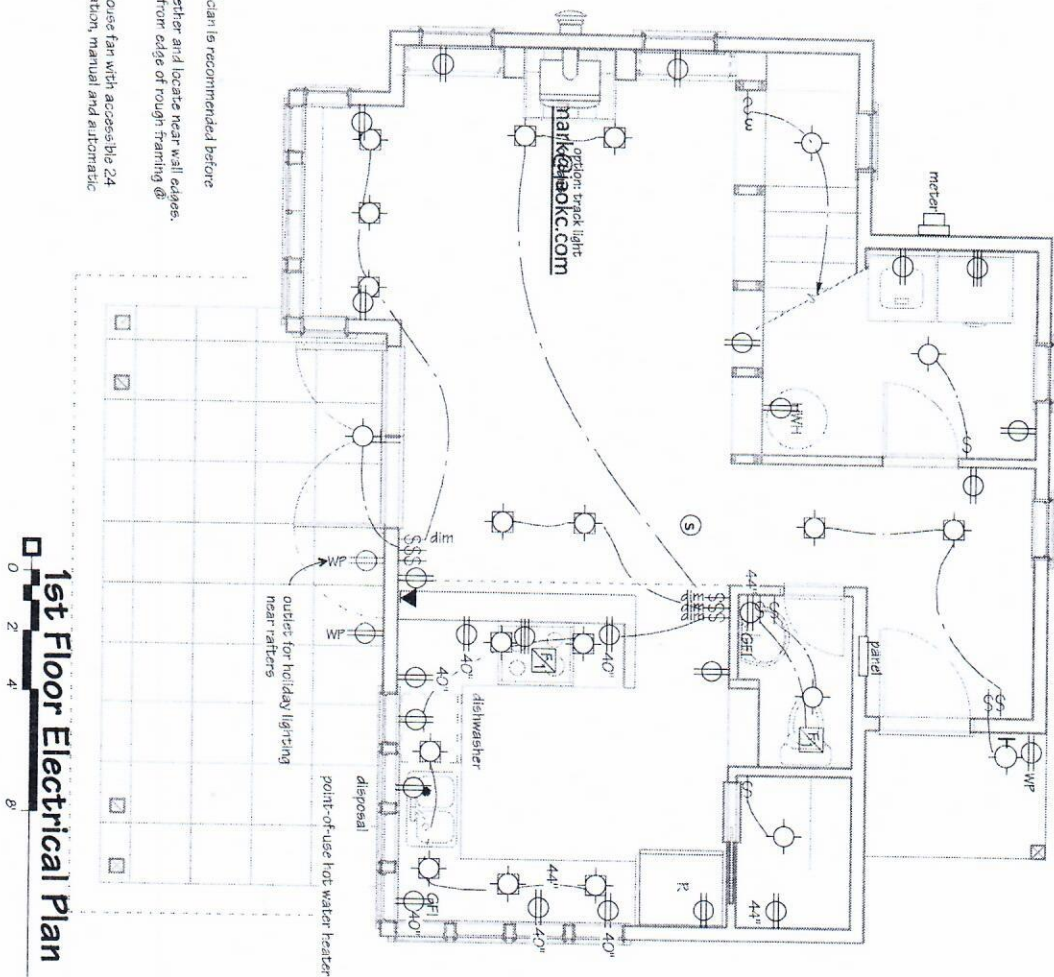


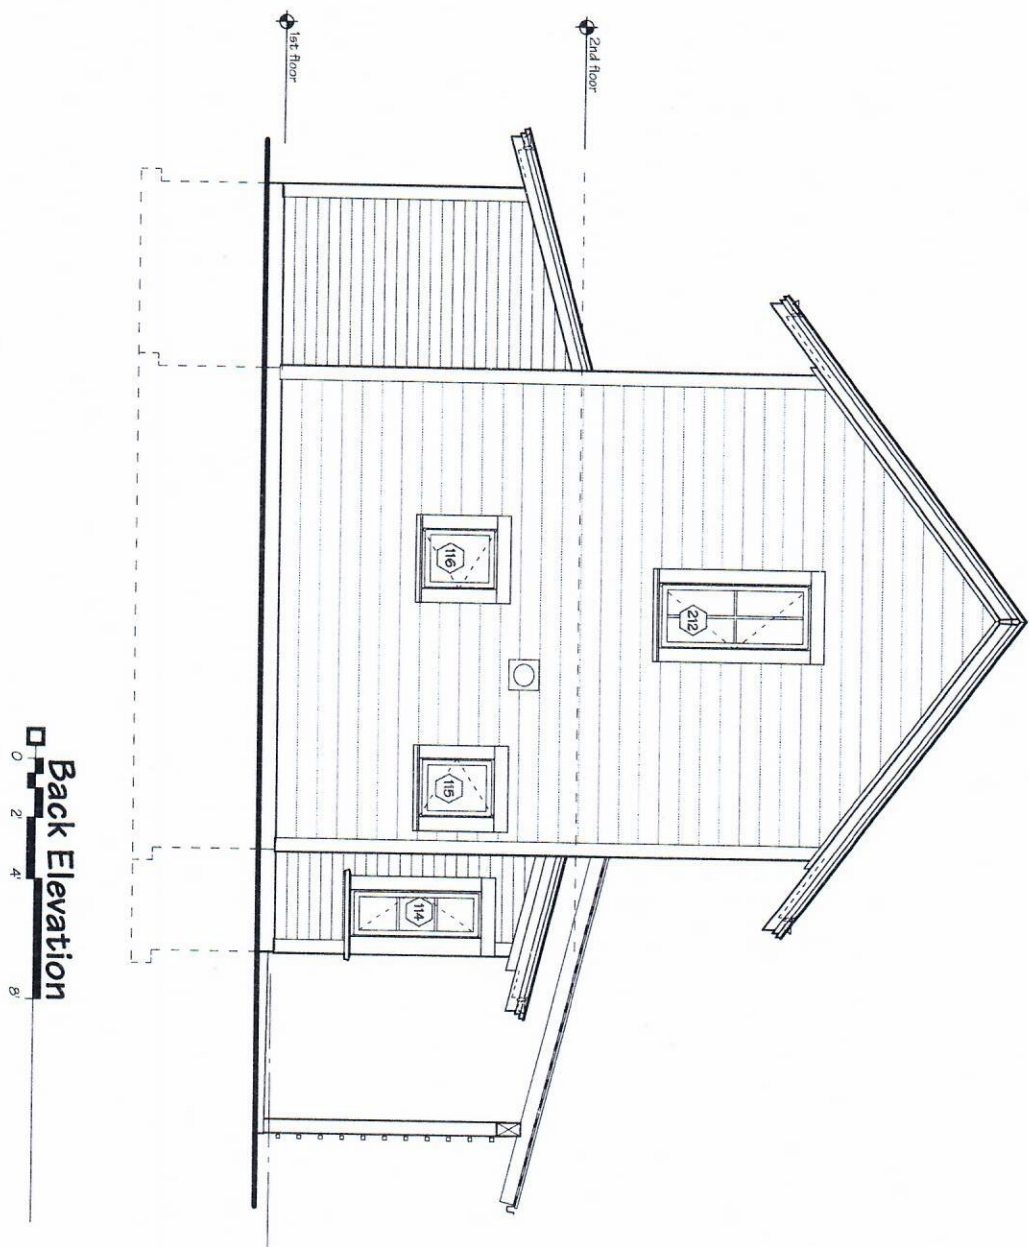7.4  
ELEVATION

Brightside
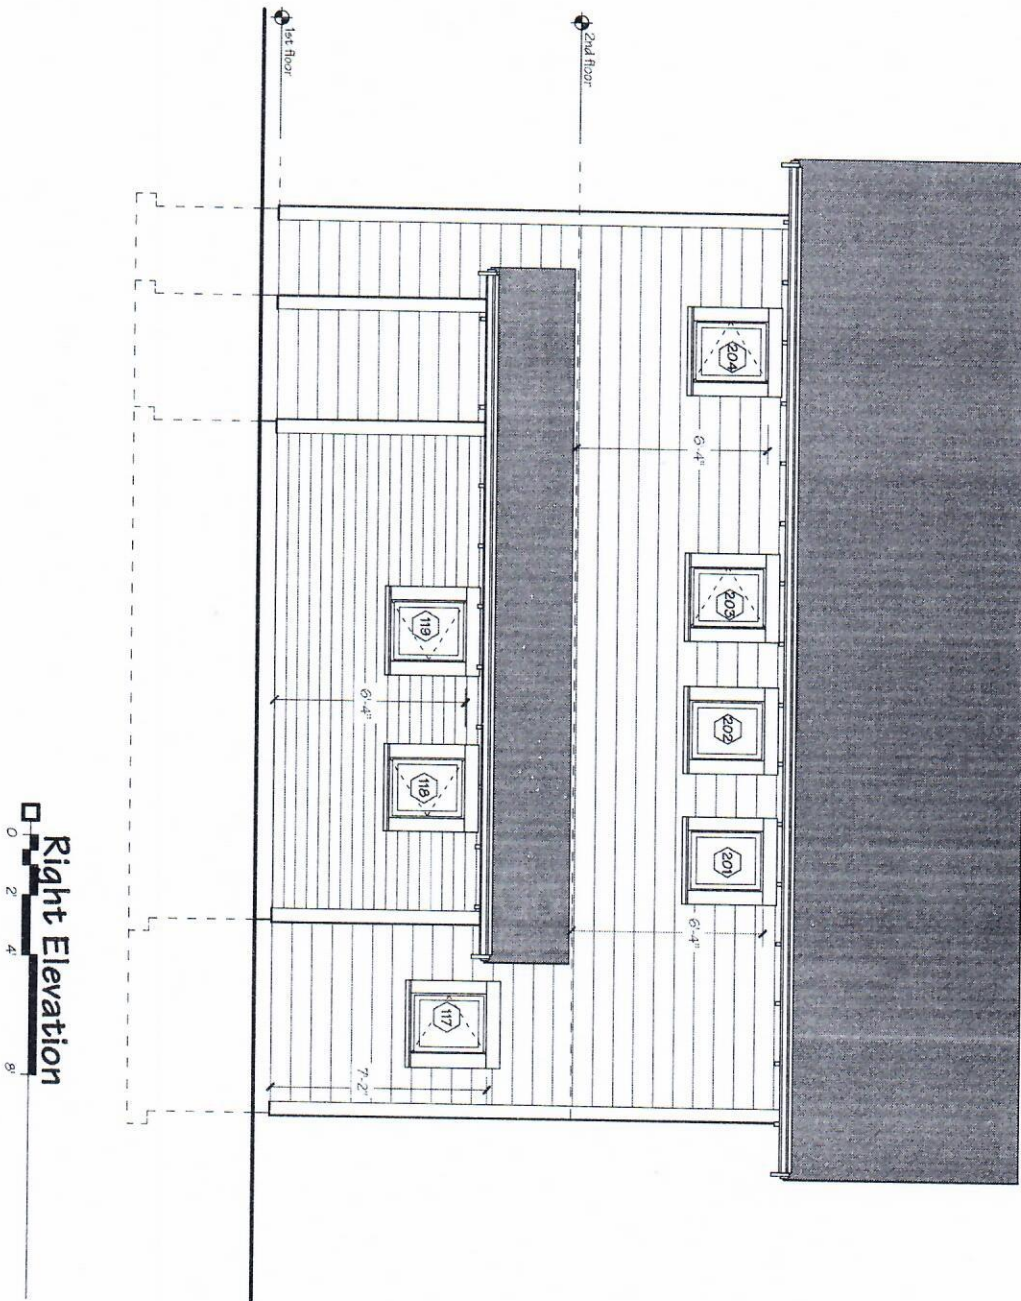
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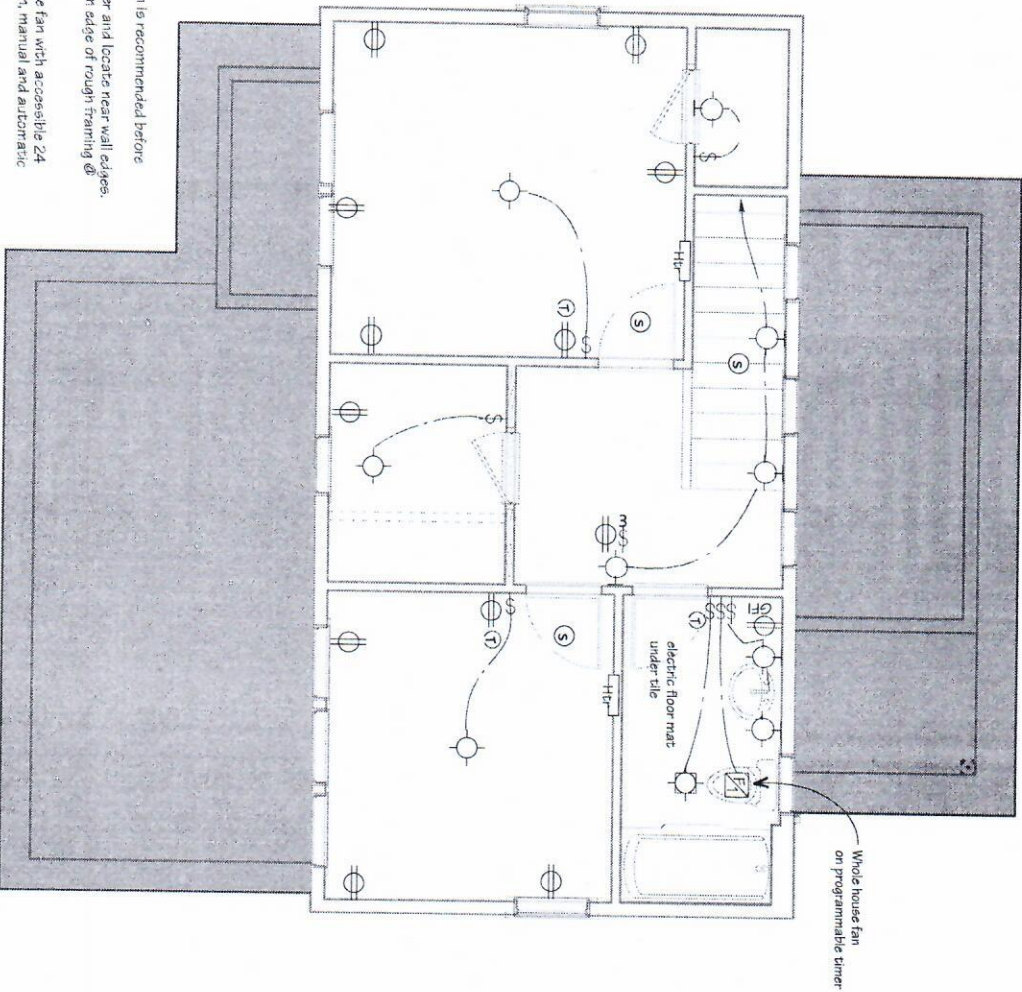
- Notes:**
- 1) A walk-through with the owner and electrician is recommended before proceeding with the installation.
  - 2) Where possible, gang electrical boxes together and locate near wall edges.
  - 3) Unless otherwise noted, allow 4 1/2" min. from edge of rough framing @ wall and to electric boxes.
  - 4) Meter to be hard located.
  - 5) Where required by code, provide a whole-house fan with accessible 24 clock timer w/ capability of continuous operation, manual and automatic control.



**1st Floor Electrical Plan**

Type	Description
—	wire
⊕	110v Duplex Outlet
⊕	110v outlet (4" above floor)
⊕	110v Outlet (switched)
⊕	110v Outlet (Master Pico)
⊕	110v Outlet (Ground Fault mt.)
⊕	220v Outlet
⊕	Junction Box
⊕	Light (Overhead)
⊕	Light (Pendant)
⊕	Light (Wall Mount)
⊕	Light (Inset Recessed Can)
⊕	Light (Exposed Can)
⊕	Light (Recessed w/ Eyeball)
⊕	4" (2) Lamp Fluorescent
⊕	4" (1) Lamp Fluorescent
⊕	2" (1) Lamp Fluorescent Pull Chain
⊕	Live feed track light
⊕	Track Light Head
⊕	Switch (Single Pole)
⊕	Switch (w/ Dimmer)
⊕	Switch (3-way)
⊕	Switch (4-way)
⊕	Switch (w/ timer)
⊕	Smoke Detector
⊕	Television Cable
⊕	Phone Jack
⊕	Thermosac
⊕	Paddle Fan
⊕	Fan 1
⊕	Fan 1-light
⊕	Base Board Elec. Heater (Ingastrics)
⊕	Wall nite Elec. Heater (with fan)
⊕	Service Panel
⊕	Electric Meter
⊕	Photo Cell Switch
⊕	Center line





**Second Floor Electrical Plan**

Symbol	Description
—	wire
⊕	110V Duplex Outlet
⊕	110V outlet, 14" above floor
⊕	110V Outlet (Switched)
⊕	110V Outlet (Water Proof)
⊕	110V Outlet (Ground Fault Int.)
⊕	220V Outlet
⊕	Junction Box
⊕	Light (Overhead)
⊕	Light (Pendant)
⊕	Light (Wall Mount)
⊕	6" Light (In-sill Recessed Can)
⊕	Light (Exposed Can)
⊕	Light (Recessed w/ Eyeball)
⊕	4 (2) Lamp Fluorescent
⊕	4 (1) Lamp Fluorescent
⊕	2 (1) Lamp Fluorescent, Full Chain
⊕	Live feed track light
⊕	Track Light Head
⊕	Switch (Single Pole)
⊕	Switch (w/ Dimmer)
⊕	Switch (3-way)
⊕	Switch (4-way)
⊕	Switch (w/ timer)
⊕	Smoke Detector
⊕	Television Cable
⊕	Phone Jack
⊕	Thermostat
⊕	Paddle Fan
⊕	Fan 1
⊕	Fan Light
⊕	Base Board Elec. Heater (long/short)
⊕	Wall mtd. Elec. Heater (with fan)
⊕	Service Panel
⊕	Electric Meter
⊕	Photo Cell Switch
⊕	Center line

- Notes:**
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  - 2) Where possible, gang electrical boxes together and locate near wall edges.
  - 3) Unless otherwise noted, allow 4 1/2" min. from edge of rough framing of wall and to electric boxes.
  - 4) Meter to be field located.
  - 5) Where required by code, provide a whole-house fan with accessible 24 clock timer w/ capability of continuous operation, manual and automatic control.





## Project: Brightside House

## Door Schedule

1) Refer to plans for orientation of casement, window

- | Door Schedule                  |            |        |                 |                  |                 |                              |                |  |  |
|--------------------------------|------------|--------|-----------------|------------------|-----------------|------------------------------|----------------|--|--|
| Project:                       |            |        |                 |                  |                 |                              |                |  |  |
| Manufacturer: To be determined |            |        |                 |                  |                 |                              |                |  |  |
| Material: Wood                 |            |        |                 |                  |                 |                              |                |  |  |
| Door #                         | Location   | Leaves | Width<br>ft. in | Height<br>ft. in | Thickness<br>in | Type                         | Notes          |  |  |
| 101                            | Entry      | 1      | 3 0             | 6 8              | 1 3/4           | 1 panel below, 4 lites above | tempered glass |  |  |
| 102                            | Patio      | 2      | 6 0             | 6 8              | 1 3/4           | Full lite                    | tempered glass |  |  |
| 103                            | Utility    | 1      | 2 0             | 6 8              | 1 3/8           | 5 Panel                      |                |  |  |
| 104                            | WC         | 1      | 2 0             | 6 8              | 1 3/8           | 5 Panel                      |                |  |  |
| 105                            | Pantry     | 1      | 2 0             | 6 8              | 1 3/8           | 5 Panel, Pocket              |                |  |  |
| 201                            | Bathroom   | 1      | 2 6             | 8 8              | 1 3/8           | 5 Panel                      |                |  |  |
| 202                            | Bathroom 2 | 1      | 2 6             | 8 8              | 1 3/8           | 5 panel                      |                |  |  |
| 203                            | Closet     | 1      | 2 4             | 6 8              | 1 3/8           | 5 Panel                      |                |  |  |
| 204                            | Bedroom 1  | 1      | 2 6             | 8 8              | 1 3/8           | 5 Panel                      |                |  |  |
| 205                            | Closet     | 1      | 2 6             | 8 8              | 1 3/8           | 5 Panel                      |                |  |  |



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NOTE: Shear Schedule must be modified and/or approved by a local Structural Engineer to meet Site Conditions

### Sample Shear Schedule

Typical Notes # 1235679					
Mark	Sheathing	Panel Edge Nailing	Top Plate Connection	Base Plate Connection	Note #
1	1/2" CDX plywood	Bd @ 6" o.c.	16d @ 6" o.c.	A35 @ 24" o.c.	16d @ 6" o.c.
2	1/2" CDX plywood	Bd @ 4" o.c.	16d @ 4" o.c.	A35 @ 16" o.c.	16d @ 4" o.c.
3	1/2" CDX plywood	Bd @ 3" o.c.	(2) rows 16d @ 6" o.c.	A25 @ 12" o.c.	16d @ 3" o.c.
4	1/2" CDX plywood	Bd @ 2" o.c.	(2) rows 16d @ 4 1/2" o.c.	A35 @ 9" o.c.	(2) rows 16d @ 4 1/2" o.c.

#### Notes:

1	Block edges with 2x4 stud flat. Nail to intermediate supports (hold nail) with Bd @ 12" o.c.
2	Bd nails shall be D131" dia x 2 1/2" long (common) - 16d nails shall be D135" dia x 3 1/2" (box)
3	Embed anchor bolts at least 7". Expansion bolts may be substituted for anchor bolts with 4" embedment.
4	2x studs or double studs nailed together with base plate nailing are required at SWS & SW4. Where 2x studs are used for SW4, stagger nails at each end of all shearwall and stud studs shall receive panel edge nailing.
5	Two studs minimum are required at each end of all shearwall and stud studs shall receive panel edge nailing.
6	All exterior walls shall be 2x4 UNO.
7	1/2" CDX may be substituted for 1/2" CDX.
8	1/2" CDX may be substituted for A35's at contractor's option
9	Studs must align within 5" of trusses, rafters or joist spaced more than 16" o.c.

NOTE: Hold Down Schedule must be modified and/or approved by a local Structural Engineer to meet Site Conditions

### Sample Holdown Schedule

Call-out	Hardware	Screws	Anchor Bolt	Embed	Holdown Post 3
2	HDU2-SD52.5	(6)SD5 1/4" x 2-1/2"	5/8" dia.	12"	(2) 2x4
4	HDU4-SD52.5	(10)SD5 1/4" x 2-1/2"	5/8" dia.	12"	(2) 2x6
5	HDU5-SD52.5	(14)SD5 1/4" x 2-1/2"	5/8" dia.	12"	4x4
6	HDU6-SD52.5	(20)SD5 1/4" x 2-1/2"	7/8" dia.	14"	4x4
11	HDU11-SD52.5	(30)SD5 1/4" x 2-1/2"	1" dia.	16"	4x8

1) Cast in: Headed bolt or all threaded w/ washer & nut.



2) Bolt solid in joist space (where occurs) under column, typ.

3) Minimum size of post at end of wall unless otherwise noted on framing plans



# MACDONALD STRUCTURAL FRAMING

CINDY MACDONALD  
LONG ISLAND, ME

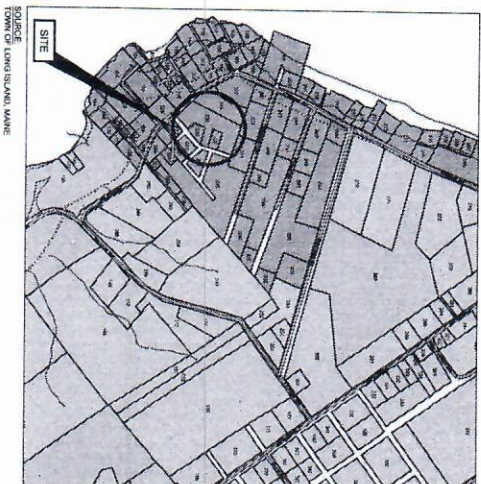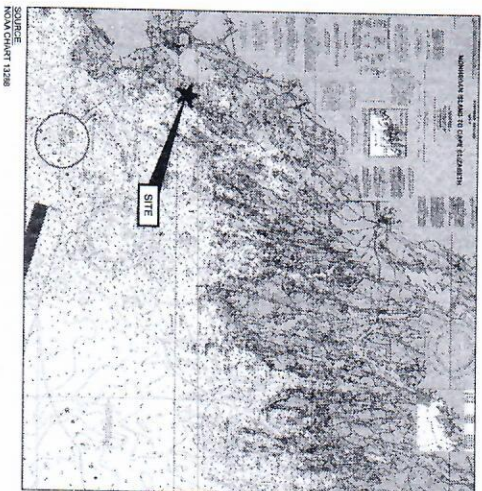

SHEET INDEX	DRAWING NO.	TITLE
1	G-001	COVER SHEET
2	G-002	NOTES & TYPICAL DETAILS
3	S-001	FOUNDATION
4	S-002	FIRST FLOOR PLAN
5	S-003	SECOND FLOOR & ROOF PLAN
6	S-004	TYPICAL SECTION

NOAA CHART 13288  
(NOT TO SCALE)

LONG ISLAND TAX MAP  
(NOT TO SCALE)

PREPARED FOR:

CINDY MACDONALD  
65 ISLAND AVE  
LONG ISLAND, MAINE

PREPARED BY:

GEI CONSULTANTS, INC.  
5 MILK STREET  
PORTLAND, ME 04101  
(207)797-8901



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GEI PROJECT NO. BDC 21-44

NO.	DATE	ISSUE/REVISION	APP.	DWG. NO.
C	5/10/2022	STRUCTURAL SET	BJB	G-001 SHEET NO. 1 OF 6
B	2/19/2022	PROGRESS SET	BJB	
A	11/11/2022	STRUCTURAL FRAMING CONCEPT	BJB	

NOTES: DRAWING IS PROPERTY OF GEI CONSULTANTS, INC. AND IS NOT TO BE REPRODUCED OR IN ANY PART, FOR ANY OTHER PROJECT WITHOUT THE WRITTEN PERMISSION OF GEI CONSULTANTS.

1. CONSTRUCTION SHALL BE IN ACCORDANCE WITH PROVISIONS OF MAINE UNIFORM BUILDING AND FIRE ALARM CODES, AND WITH THE LATEST EDITIONS THEREOF.

- [illegible]

### 1. CONCRETE MIX DESIGN

2. MANUFACTURER'S DETAILS INSTRUCTIONS FOR INSULATED BLOCK SYSTEM
3. CERTIFICATES FOR ENGINEERED LUMBER
4. CONNECTION HARDWARE
5. ADDITIONS OR SUBSTITUTIONS FROM THAT SPECIFIED ON THE STRUCTURAL DRAWINGS

1. STRUCTURAL REINFORCED CONCRETE AND REINFORCING SHALL BE PLACED IN ACCORDANCE

2. ALL CONTROL AND CONSTRUCTION JOINTS SHALL BE AS DETAILED AND PLACED IN LOCATIONS AS SHOWN ON THE DRAWINGS.
3. MIX DESIGN


Fe size (µm)	Max egg Enrichment	Mean central air (%)	Mean Enrichment	Max VWC Ratio
3000	5.7 ± 1	650	43	

1. ALL FOUNDATIONS SHALL BE PINNED TO EXISTING LEDGE ON SITE AS DETERMINED


2. If a ladder is determined not to be present, the following bearing and frost protection criteria may be used after an inspection of subsurface conditions by the engineer:  
ALLOWABLE BEARING PRESSURE ..... 3000 psf  
FROST PENETRATION ..... 4.5 ft
3. BODILY PROTECTION WALLS WITH CLAY GROUT (BODILY PROTECTANT)  
BODILY PROTECTANT IS TO BE APPLIED TO THE EXPOSED SURFACE OF THE EXISTING SUBGRADE AND BODILY PROTECTANT IS TO BE APPLIED TO THE EXISTING SUBGRADE BEFORE BRICKS TO MINIMIZE PERMEABILITY TO THE NEW SUBGRADE  
PROVIDE A HIGH DENSITY STROKE DRAINAGE LAYER BELOW ALL SLABS

1 STRUCTURAL FRAMING MATERIAL SHALL BE DIMENSIONED IN ORDER THAT MEET & TIE OVER


1. STAINLESS STEEL NAILS APPROVED FOR APPLICATION BY MANUFACTURER.
2. ALL TRIMMER/GRADING COMPONENTS SHALL BE CONSIDERED NECESSARY TO THE PROPER OPERATION OF THE EQUIPMENT. THE FOLLOWING ITEMS ARE REQUIRED FOR PROPER FORMING, STRIPPING, AND SPLITTING MATERIALS:
  - (a) TRIMMER/GRADING COMPONENTS SHALL BE CONSIDERED NECESSARY TO THE PROPER OPERATION OF THE EQUIPMENT.
  - (b) TRIMMER/GRADING COMPONENTS SHALL BE CONSIDERED NECESSARY TO THE PROPER OPERATION OF THE EQUIPMENT.
  - (c) TRIMMER/GRADING COMPONENTS SHALL BE CONSIDERED NECESSARY TO THE PROPER OPERATION OF THE EQUIPMENT.
  - (d) TRIMMER/GRADING COMPONENTS SHALL BE CONSIDERED NECESSARY TO THE PROPER OPERATION OF THE EQUIPMENT.
  - (e) TRIMMER/GRADING COMPONENTS SHALL BE CONSIDERED NECESSARY TO THE PROPER OPERATION OF THE EQUIPMENT.
  - (f) TRIMMER/GRADING COMPONENTS SHALL BE CONSIDERED NECESSARY TO THE PROPER OPERATION OF THE EQUIPMENT.
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  - (h) TRIMMER/GRADING COMPONENTS SHALL BE CONSIDERED NECESSARY TO THE PROPER OPERATION OF THE EQUIPMENT.
  - (i) TRIMMER/GRADING COMPONENTS SHALL BE CONSIDERED NECESSARY TO THE PROPER OPERATION OF THE EQUIPMENT.
  - (j) TRIMMER/GRADING COMPONENTS SHALL BE CONSIDERED NECESSARY TO THE PROPER OPERATION OF THE EQUIPMENT.
  - (k) TRIMMER/GRADING COMPONENTS SHALL BE CONSIDERED NECESSARY TO THE PROPER OPERATION OF THE EQUIPMENT.
  - (l) TRIMMER/GRADING COMPONENTS SHALL BE CONSIDERED NECESSARY TO THE PROPER OPERATION OF THE EQUIPMENT.
  - (m) TRIMMER/GRADING COMPONENTS SHALL BE CONSIDERED NECESSARY TO THE PROPER OPERATION OF THE EQUIPMENT.
  - (n) TRIMMER/GRADING COMPONENTS SHALL BE CONSIDERED NECESSARY TO THE PROPER OPERATION OF THE EQUIPMENT.
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  - (q) TRIMMER/GRADING COMPONENTS SHALL BE CONSIDERED NECESSARY TO THE PROPER OPERATION OF THE EQUIPMENT.
  - (r) TRIMMER/GRADING COMPONENTS SHALL BE CONSIDERED NECESSARY TO THE PROPER OPERATION OF THE EQUIPMENT.
  - (s) TRIMMER/GRADING COMPONENTS SHALL BE CONSIDERED NECESSARY TO THE PROPER OPERATION OF THE EQUIPMENT.
  - (t) TRIMMER/GRADING COMPONENTS SHALL BE CONSIDERED NECESSARY TO THE PROPER OPERATION OF THE EQUIPMENT.
  - (u) TRIMMER/GRADING COMPONENTS SHALL BE CONSIDERED NECESSARY TO THE PROPER OPERATION OF THE EQUIPMENT.
  - (v) TRIMMER/GRADING COMPONENTS SHALL BE CONSIDERED NECESSARY TO THE PROPER OPERATION OF THE EQUIPMENT.
  - (w) TRIMMER/GRADING COMPONENTS SHALL BE CONSIDERED NECESSARY TO THE PROPER OPERATION OF THE EQUIPMENT.
  - (x) TRIMMER/GRADING COMPONENTS SHALL BE CONSIDERED NECESSARY TO THE PROPER OPERATION OF THE EQUIPMENT.
  - (y) TRIMMER/GRADING COMPONENTS SHALL BE CONSIDERED NECESSARY TO THE PROPER OPERATION OF THE EQUIPMENT.
  - (z) TRIMMER/GRADING COMPONENTS SHALL BE CONSIDERED NECESSARY TO THE PROPER OPERATION OF THE EQUIPMENT.
3. ALL TRIMMER/GRADING COMPONENTS SHALL BE CONSIDERED NECESSARY TO THE PROPER OPERATION OF THE EQUIPMENT.

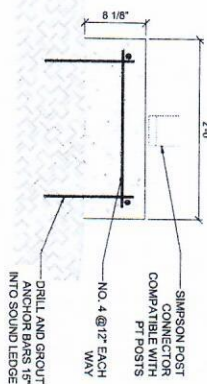


3  
DETAIL  
POST PAID

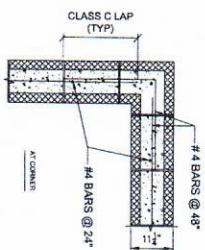

**4** DETAIL  
TYPICAL REINFORCEMENT DETAILS FOR  
CONCRETE FILLED ICF WALLS

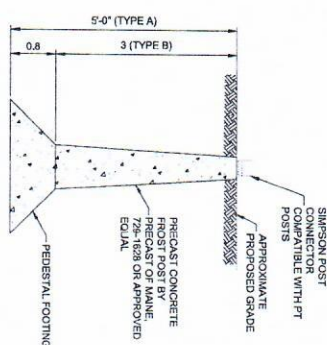

5  
-  
DETAIL  
POST PA

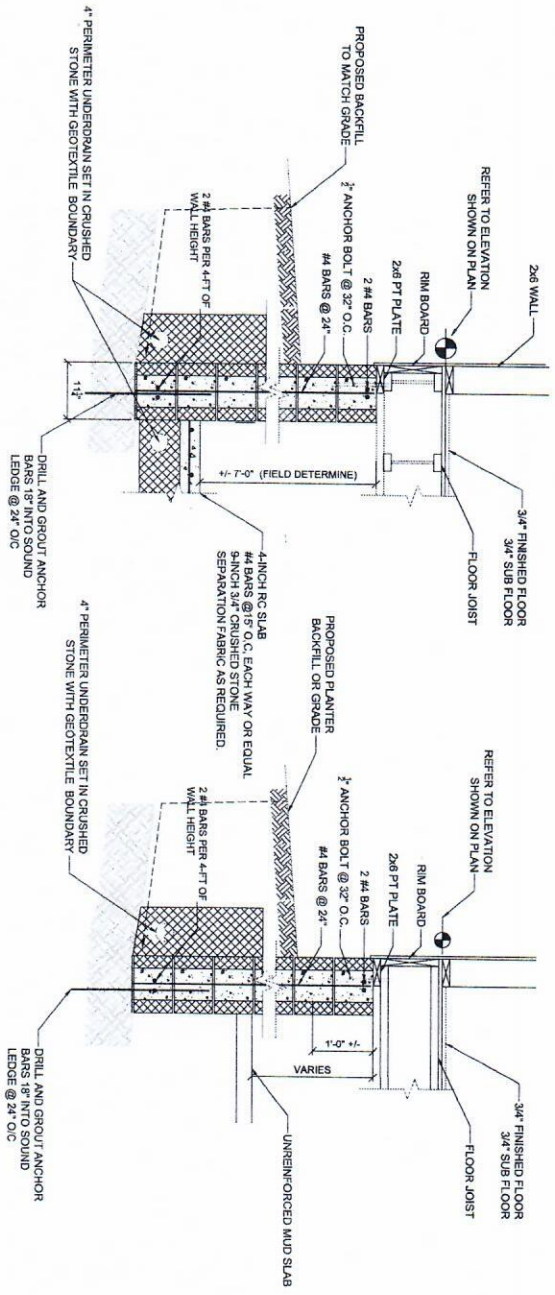


1 DETAIL AT DAY LIGHT BASEMENT  
- TYPICAL ICF FOOTING W/ LEDGE

2	DETAIL
-	ICF CRAWL SPACE W/ LEDGE

[illegible]



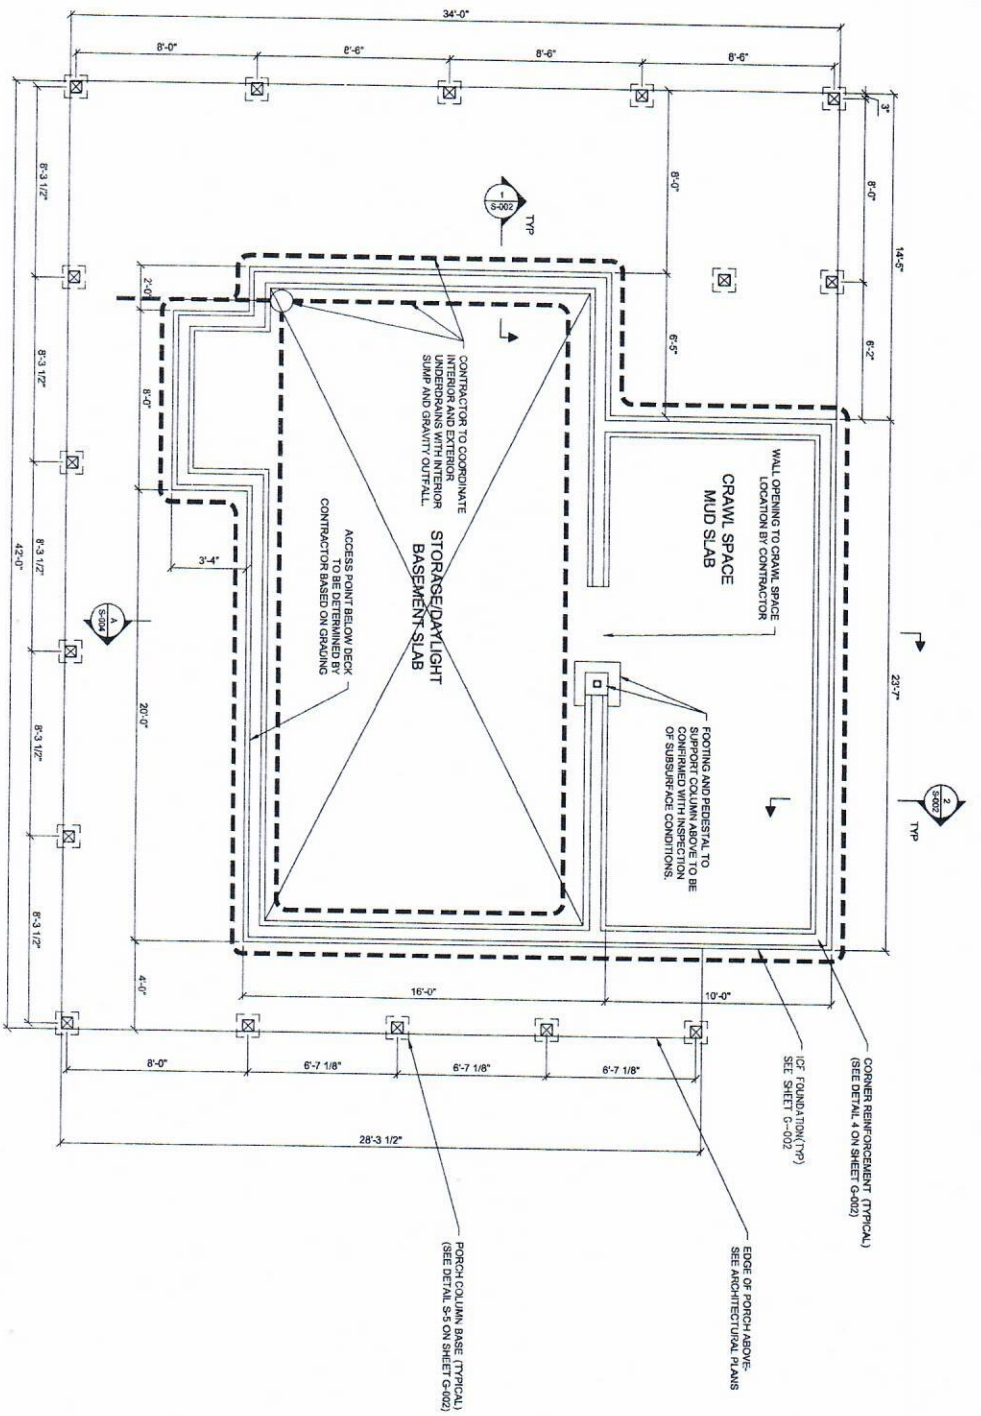

FOUNDATION PLAN



<p>Attention: If this sheet has been revised, the revision number and description must be indicated in the revision table.</p>		<p>DESIGNED BY: BJB</p>		<p>PROJECT NAME: MACDONALD HOUSE FOUNDATION</p>		<p>SHEET NO: S-001</p>	
<p>DRAWN BY: EEP</p>		<p>CHECKED BY: BJB</p>		<p>DATE: 5/10/2022</p>		<p>REVISION: 1</p>	
<p>APPROVED BY: PJB</p>		<p>PROJECT VALUE: \$10,000</p>		<p>DATE: 5/10/2022</p>		<p>REVISION: 2</p>	
<p>GEI CONSULTANTS</p>		<p>CINDY MACDONALD</p>		<p>65 ISLAND AVE</p>		<p>LONG ISLAND, ME</p>	
<p>04050</p>		<p>MACDONALD HOUSE FOUNDATION</p>		<p>65 ISLAND AVE</p>		<p>LONG ISLAND, ME</p>	
<p>04050</p>		<p>FOUNDATION</p>		<p>DATE: 5/10/2022</p>		<p>REVISION: 3</p>	
<p>NO</p>		<p>DATE</p>		<p>REVISION</p>		<p>DESCRIPTION</p>	
<p>1</p>		<p>5/10/2022</p>		<p>STRUCTURAL SET</p>		<p>BJB</p>	
<p>2</p>		<p>5/10/2022</p>		<p>PROPOSED SET</p>		<p>BJB</p>	
<p>3</p>		<p>5/10/2022</p>		<p>STRUCTURAL FRAMING</p>		<p>BJB</p>	
<p>4</p>		<p>5/10/2022</p>		<p>CONCEPT</p>		<p>BJB</p>	


Attention: _____ I am sending you _____ copies of these drawings for _____ review. Changes to _____ must be made on _____ and returned to _____ by _____ Date: _____		Designed: BJB	 <b>GEI</b> GEI CONSULTANTS INC. 10000 W. 10th Ave. Suite 100 Denver, CO 80202	CINDY MACDONALD 65 ISLAND AVE LONG ISLAND, ME 04050	<b>MACDONALD HOUSE FOUNDATION</b> 65 ISLAND AVE LONG ISLAND, ME 04050	SHEET NAME <b>FIRST FLOOR PLAN</b>	SHEET NO. <b>S-002</b>																				
		Drawn: EEP Checked: BJB Approved: APP, BY P.E. No. PEP# GEI Project VALUE																									
<table border="1"> <thead> <tr> <th>NO</th> <th>DATE</th> <th>ISSUE/REVISION</th> <th>APP</th> </tr> </thead> <tbody> <tr> <td>1</td> <td>5/10/2022</td> <td>FINAL DESIGN</td> <td>BJB</td> </tr> <tr> <td>2</td> <td>2/18/2022</td> <td>PROGRESS SET</td> <td>BJB</td> </tr> <tr> <td>3</td> <td>1/11/2022</td> <td>STRUCTURAL FRAMING</td> <td>BJB</td> </tr> <tr> <td>4</td> <td></td> <td>CONCEPT</td> <td>BJB</td> </tr> </tbody> </table>								NO	DATE	ISSUE/REVISION	APP	1	5/10/2022	FINAL DESIGN	BJB	2	2/18/2022	PROGRESS SET	BJB	3	1/11/2022	STRUCTURAL FRAMING	BJB	4		CONCEPT	BJB
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4		CONCEPT	BJB																								

BARKER, BAILEY B [WenatcheeCNDY MACDONALD\_Proposals10029 Island Ave-Lang Island700\_CADOngrntHwy65 Island Ave Foundation\_Base.Dwg - 5/10/20





Breney Barker

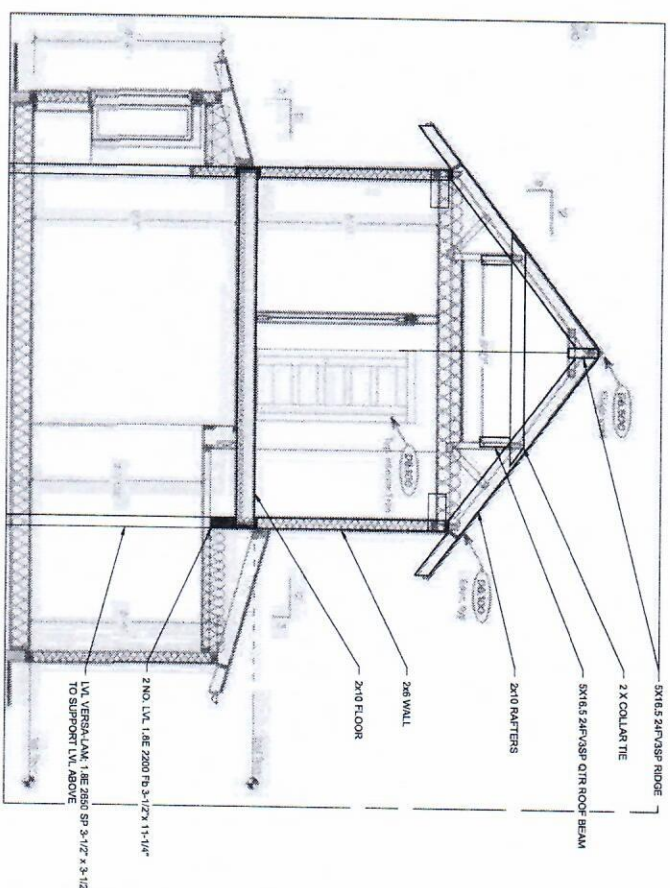


**A**  
**TYPICAL SECTION**  
SCALE: 3/8" = 1'

**NOTES:**


1. THIS SECTION SHOWS ALTERNATE STRUCTURAL FRAMING SUPERIMPOSED ON CLIENT PROVIDED BUILDING SECTION.

Attention: 1. This schedule has been prepared in accordance with the provisions of the contract. 2. This drawing is not original work.			
Designer: BJB Drawn: EEP Checked: BJB Approved: - P.E. No. - GEI Project: -	 GEI CONSULTANTS 65 ISLAND AVE. LONG ISLAND, ME 04050 (207) 779-8877		
CHUDY MACDONALD 65 ISLAND AVE. LONG ISLAND, ME 04050		MACDONALD HOUSE FOUNDATION 65 ISLAND AVE LONG ISLAND, ME 04050	
NO. DATE C 5/10/2022 B 2/18/2022		SHEET NAME TYPICAL SECTION S-004	
STRUCTURAL SET PROGRESS SET ISSUEREVISION APP		SHEET NO.	




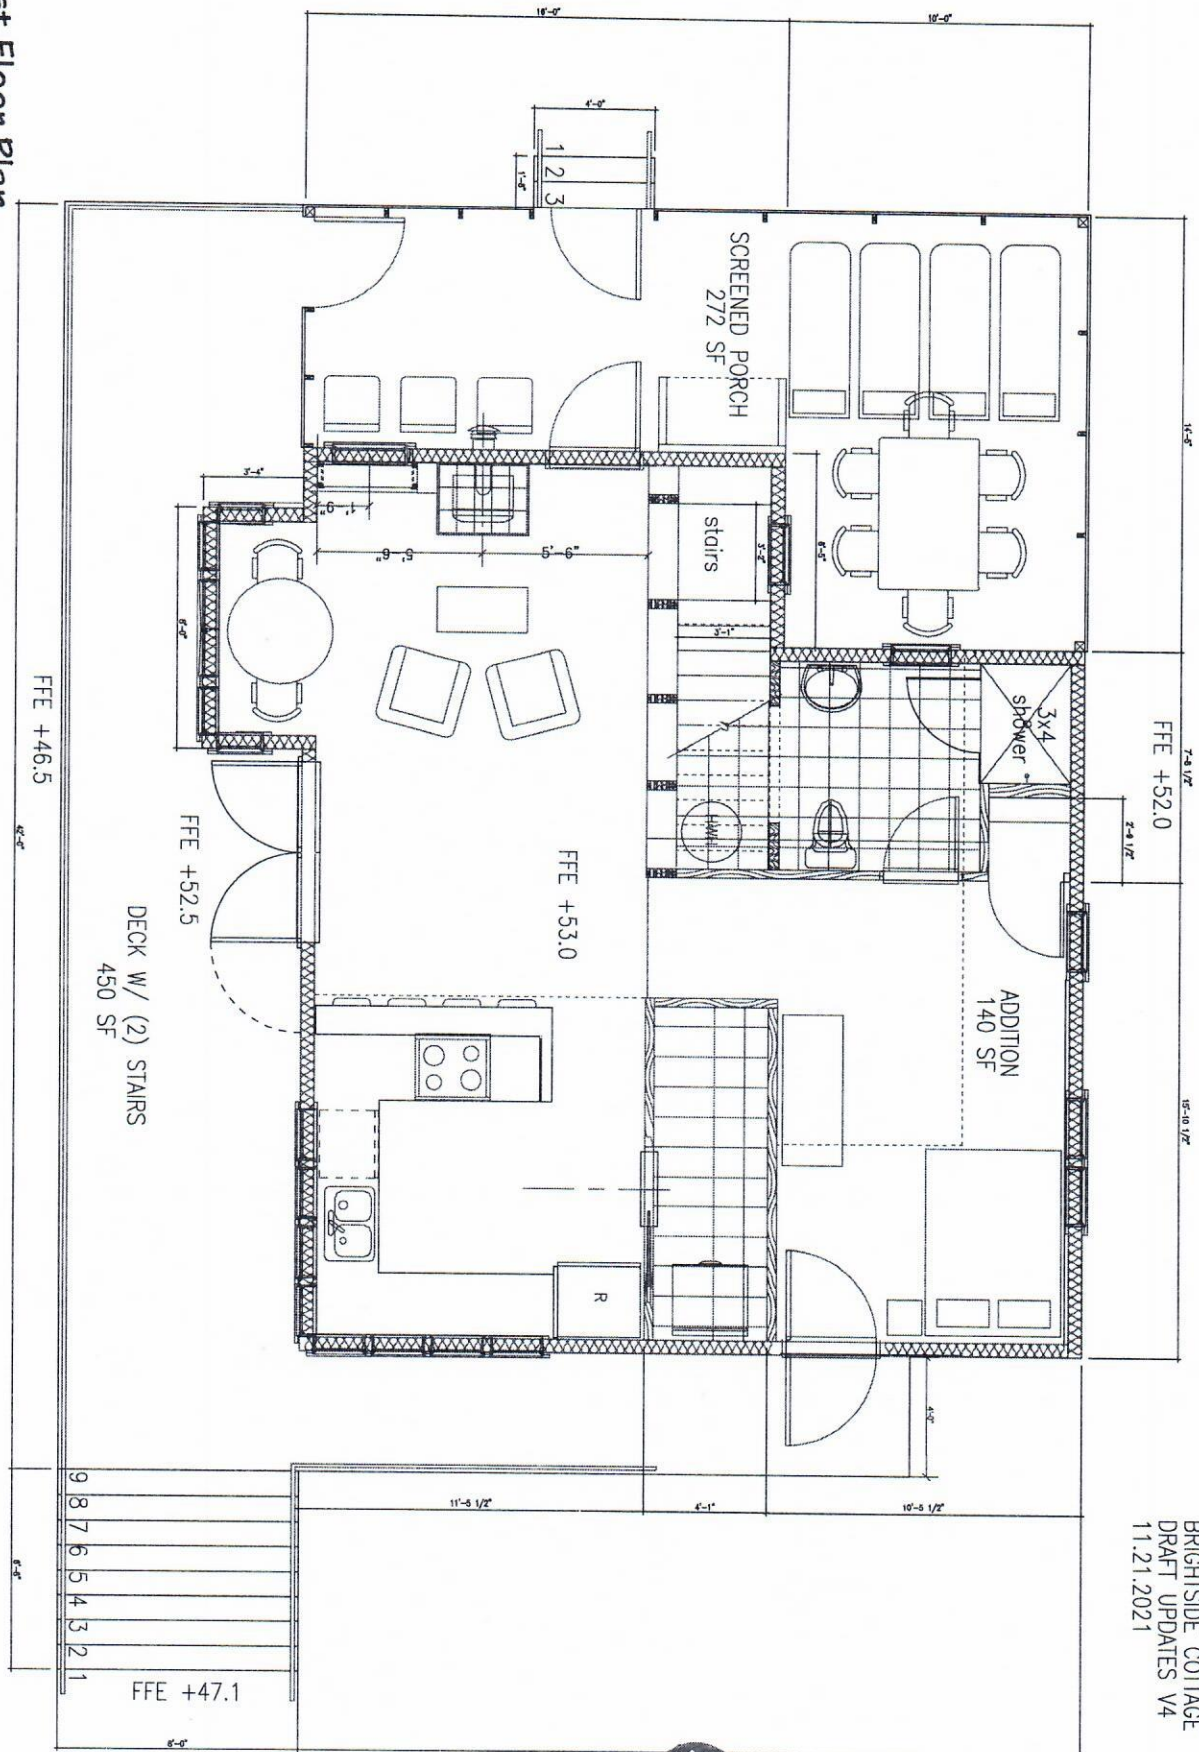

BRIGHTSIDE COTTAGE  
DRAFT UPDATES V4  
11.21.2021

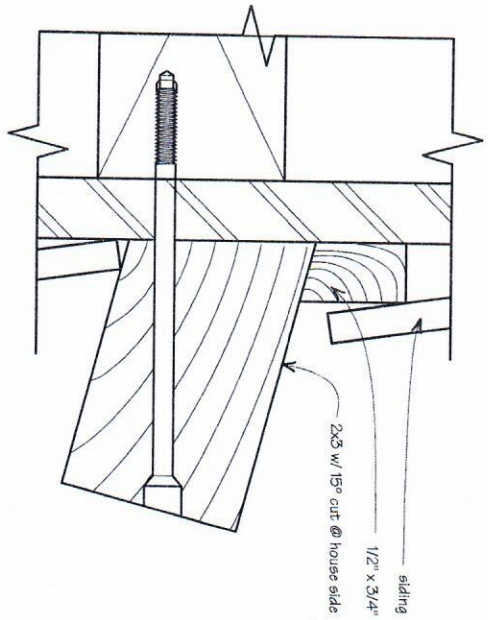

© Trim Band  
0 1/2" 1" 2"

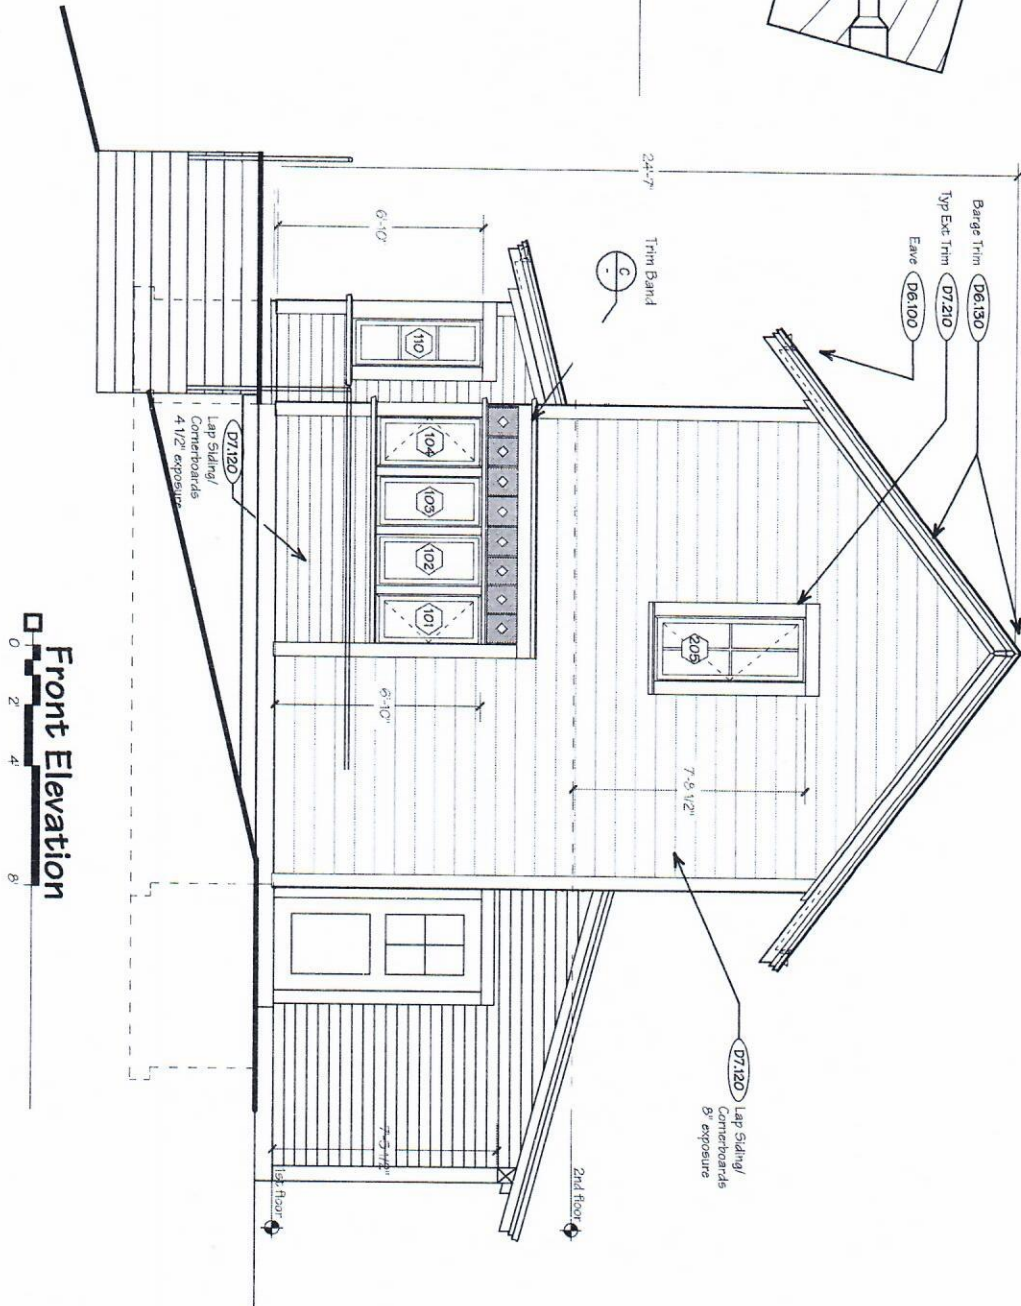

Front Elevation  
0 2 4 8'

BRIGHTSIDE COTTAGE  
DRAFT UPDATES V4  
11.21.2021

7.1  
ELEVATION


Brightside

GoodFit  
Cottages and Small Houses

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BRIGHTSIDE COTTAGE  
DRAFT UPDATES V4  
11.21.2021



Left Elevation

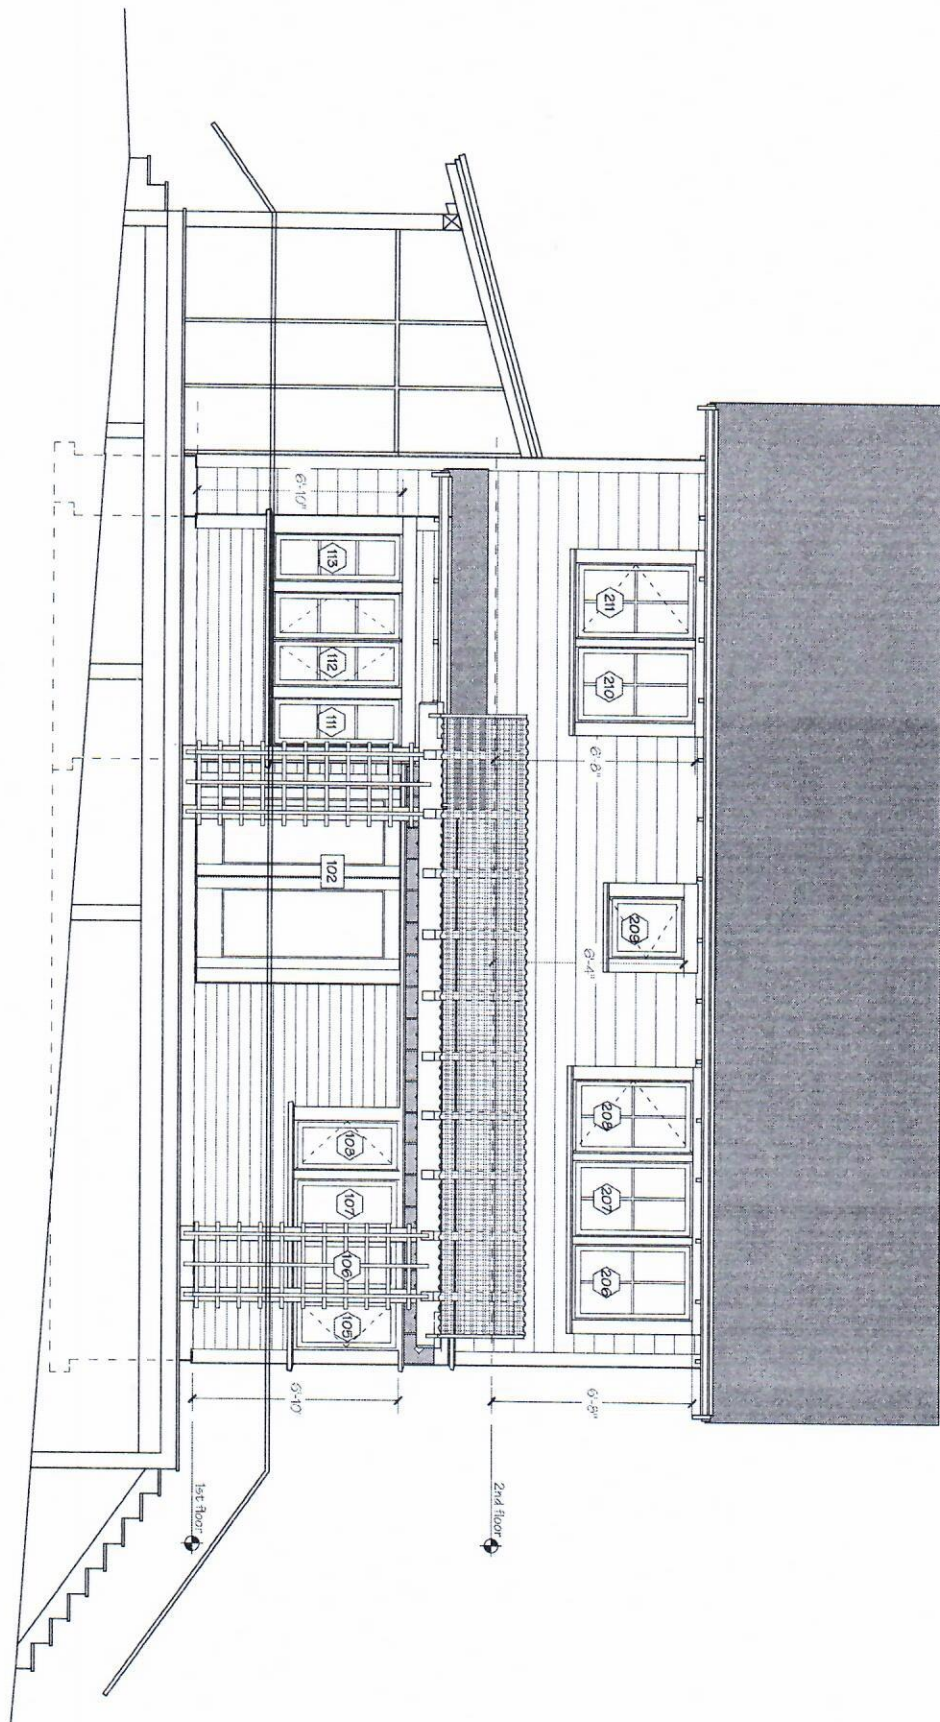7.2  
ELEVATION

Brightside

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